AMENDMENT OF SOLICITATION/MODIFICATION OF CONTRACT			1. CONTRACT ID CODE		PAGE OF PAGES	
						1 6
2. MODIFICATION NO.:	3. EFFECTIVE DATE	4. REQUISITION/PURCHASE REQ. NO.		Q. NO.	PROJECT NO. (If applicable)	
0001	JUN 03, 2005	W81W3G-203	35-71	81		
6. ISSUED BY CODE	CA31	7. ADMINISTERED BY:			CODE	E1P0100
Department of the Army Baltimore District, Corps of Engineers Contracting Division		Contracting Division, Contraction CENAB-CT-C	ts Brai	nch		
P.O. Box 1715		10 S. Howard ST. Room 7000	)			
Baltimore MD 21203-1715	a land	Baltimore, MD 21203-1715	( )	04 41(E)(E)	TENTE OF GO	I LOVE A PROMINO
8. NAME AND ADDRESS OF CONTRACTOR (No., s	treet, county, State and ZIP C	rode)	(x)	W912DR-0		LICITATION NO.
			X	9B. DATED (		1
				MAY 19, 2		'
				10A. MODIFI NO.	CATION OF	CONTRACT/ ORDER
				110.		
				10B. DATED	(SEE ITEM 1.	3)
CODE	FACILITY CODE		ı			
11. THIS	S ITEM ONLY APPLIES T	O AMENDMENTS OF SOLI	CITA	TIONS		
The above numbered solicitation is amended as set		nd date specified for receipt of C	offers i	is not extend	led.	
DATE OF RECEIPT OF PROPOSAI	LS 3:30 PM, LOCA	AL TIME, JUN 17, 2009	5			
Offers must acknowledge receipt of this amendment prior to the	hour and date specified in the solid	citation or as amended, by one of the	followi	ng methods:		
(a) By completing Items 8 and 15, and returning 1 copies	•				ubmitted; or (c)	By separate letter or
telegram which includes a reference to the solicitation and amend	lment numbers. FAILURE OF YO	OUR ACKNOWLEDGMENT TO E	E REC	EIVED AT THE P	LACE DESIGN	ATED FOR THE
RECEIPT OF OFFERS PRIOR TO THE HOUR AND DATE SI					=	= -
submitted, such change may be made by telegram or letter, provi specified.	ded each telegram or letter makes	reference to the solicitation and this	amendr	nent, and is receive	ed prior to the op	bening hour and date
12. ACCOUNTING AND APPROPRIATION DATA (A	If required)					
13. THIS I' IT MO	TEM APPLIES ONLY TO M DIFIES THE CONTRACT/O	ODIFICATIONS OF CONTRA ORDER NO. AS DESCRIBED I	CTS/C N ITE!	ORDERS, M 14.		
A. THIS CHANGE ORDER IS ISSUED PURS No. ITEM 10A					MADE IN THE	E CONTRACT ORDER
B. THE ABOVE NUMBERED CONTRACT/ORDER IS MODIFIED TO REFLECT THE ADMINISTRATIVE CHANGES (such as changes in paying office, appropriation date, etc.) SET FORTH IN ITEM 14, PURSUANT TO THE AUTHORITY OF FAR43.103(b)			paying office,			
C. THIS SUPPLEMENTAL AGREEMENT IS ENTERED INTO PURSUANT TO AUTHORITY OF: changes clause FAR 52.243.1						
D. OTHER (Specify type of modification and authority)						
E. IMPORTANT: Contractor is not, is required to sign this document and returncopies to the issuing office.						
14. DESCRIPTION OF AMENDMENT/MODIFICATI	ON (Organized by UCF section	on headings, including solicitati	ion/con	tract subject ma	tter where fea	sible.)
		C TESTING FACILITY A, PENNSYLVANIA				
	SEE THE FO	LLOWING PAGES				
Except as provided herein, all terms and conditions of the	e document referenced in Item	9A or 10A, as heretofore change	ged, re	mains unchanged	d and in full fo	orce and effect
15A. NAME AND TITLE OF SIGNER (Type or print)		16A. NAME AND TITLE OF	CON	FRACTING OF	FICER (Type	or print)
15B. CONTRACTOR/OFFEROR	15C. DATE SIGNED	16B. UNITED STATES OF A	AMER	ICA	10	6C. DATE SIGNED
(signature of manage of the interest of the in		BY				
(signature of person authorized to sign)	20	(Signature of C	ontrac	0 00 /	EODM 20 (DI	
NSN 7540-01-152-8070 PREVIOUS EDITION UNUSABLE	30	0-105		STANDARD Prescribed by FAR (48 CFR)	GSA	2v. 10-63)

#### **SPECIFICATIONS:**

- 1) Page 01050—1, Paragraph 1.1.2: Delete the second sentence beginning "Foundation Exploration..." and substitute the following: "The Contractor may acquire a copy of the Geotechnical Report by contacting the Contracting Office Representative. It is further recommended that a Geotechnical Engineer be present to evaluate all excavation, backfill materials, and verify compliance with all recommendations within the Geotechnical Report."
- 2) <u>Pages 15400—32 through 34, Paragraph 3.8</u>: Revised fixture numbers to match drawings.

#### **DRAWINGS**:

- 3) <u>Plate 2, Site Plan and Details</u>: Change the following items:
  - a. Detail 1 Add a sloped surface to concrete around bollard.
  - b. Site Plan Revise location of exterior door near Tel-Com Room.
- 4) Plate 3, Site Demolition Plan: Change the following items:
  - a. Add top of core elevation to the Boring Log. Top of Core elevation is 993.583'+\-
- 5) <u>Plate 5, Site Utility Plan</u>: Add two additional notes to General Site Utility Notes as follows:

"Contractor shall notify site Point of Contact (POC) a minimum of (7) days prior to any water service disruption. No single water disruption shall be longer than 24 hour."

"Contractor shall also coordinate with and notify the local fire company of any water service interruption at the site."

- 6) Plate 9, Foundation Plan: Change the following items:
  - a. Revised the location of CMU Wall expansion joints at three locations to match Architectural drawings.
  - b. Changed Typical Slab on Grade Control/Construction Joint Detail (Control Joint). Saw Cut Depth is changed from 1" to 1 1/2".

- 7) <u>Plate 10, First Floor Framing Plan</u>: Change the following items:
  - a. Revised the location of CMU Wall expansion joints at three locations to match Architectural drawings.
  - b. Revise Plate in accordance with the attached Sketch A-S-1, dated May 27, 2005.
  - c. Relocate turn-down slab outside of Door 101 to coordinate with Architectural change. Slab shall begin 4'-8" from the exterior face of CMU at the north wall.
- 8) <u>Plate 11, Roof Framing Plan:</u> Change the following items:
  - a. Add CMU Wall expansion joints at three locations coordinated with Architectural drawings.
  - b. Relocate Door 101 lintel to coordinate with Architectural change. graphical change.
- 9) <u>Plate 12, Foundation Sections and Details</u>: Change the following items:
  - a. Section 2 Remove 30# felt to permit poured concrete sill to adhere to CMU. Added expansion joint at the inside of CMU wall to permit floor slab to float. See attached Sketch A-S-2, dated May 27, 2005.
  - b. Section 9 Revise section in accordance with the attached Sketch A-S-3, dated May 27, 2005.
- 10) <u>Plate 13, Framing Sections and Details</u>: Change the following items:
  - a. Section 5 Revise note referencing lintel schedule to read "Precast Concrete Lintel See Lintel Schedule on Sheet S-8."
  - b. Section 6 Revise note referencing lintel schedule to read "Precast Concrete Lintel See Lintel Schedule on Sheet S-8."
- 11) <u>Plate 15, Typical Masonry Details, Typical Wall Section at Bond Beams:</u> Revise section in accordance with the attached Sketch A-S-4, dated May 27, 2005.
- 12) Plate 16, Structural Notes, Schedules and Abbreviations: Change the following items:
  - a. Structural Note 4 Change note to read "THE DESIGN ALLOWABLE SOIL BEARING PRESSURE IS 3000 PSF."
  - b. Structural Note 7 Delete.

### 13) <u>Plate 17, Basement Plan</u>: Change the following items:

- a. Basement Floor Plan Revise plan in accordance with the attached Sketch A-A-1, dated May 27, 2005.
- b. Basement Floor Plan Revise plan in accordance with the attached Sketch A-A-2, dated May 27, 2005.
- c. Basement Floor Plan Deleted note for filter fabric wrap on 4" perforated drain.

### 14) <u>Plate 18, First Floor Plan</u>: Change the following items:

- a. First Floor Plan at Toilet Room 104 Revise plan in accordance with the attached Sketch A-A-3, dated May 27, 2005.
- b. First Floor Plan Revise plan in accordance with the attached Sketch A-A-3, dated May 27, 2005.
- c. First Floor Plan Revise plan in accordance with the attached Sketch A-A-4, dated May 27, 2005.

### 15) Plate 20, North and South Elevations: Change the following items:

- a. North Elevation Revise note at foundation to read "Reinforced CMU Retaining Wall".
- b. South Elevation Revise note at foundation to read "Reinforced CMU Retaining Wall".

#### 16) Plate 21, East and West Elevations: Change the following items:


- a. East Elevation Revise plan in accordance with the attached Sketch A-A-5, dated May 27, 2005.
- b. East Elevation Revised note at foundation to read "Reinforced CMU Retaining Wall".
- c. Window Details Revise plan in accordance with the attached Sketch A-A-6, dated May 27, 2005.

- 17) <u>Plate 22, Building Sections</u>: Change the following items:
  - a. Building Sections 1 and 2 Delete requirements to only wrap 4" perforated drain pipe in filter fabric. Add requirement to provide filter fabric between porous fill and earth.
  - b. Building Sections 1 and 2 Indicate CMU bond beams in masonry walls with note to see structural drawings.
  - c. Section 3 Change section to indicate ramp slab isolated from the foundation wall with expansion joint material.
- 18) <u>Plate 23, Reflected Ceiling Plan:</u> Revise plan in accordance with the attached Sketches A-A-7 and A-A-8, dated May 27, 2005.
- 19) <u>Plate 24, Wall Sections and Details</u>: Delete this plate in its entirety as originally issued and substitute the attached revised like-numbered plate, dated May 27, 2005.
- 20) <u>Plate 25, Schedules and Details</u>: Change the following items:
  - a. Door Schedule Revise schedule in accordance with the attached Sketch A-A-11, dated May 27, 2005.
  - b. Door Types Revise in accordance with the attached Sketch A-A-11, dated May 27, 2005.
  - d. Details 1 and 2 Revise details in accordance with the attached Sketches A-A-9 and A-A-10, dated May 27, 2005.
- 21) <u>Plate 26, Partition Types, Schedules, and Details, Partition Type E:</u> Revise in accordance with the attached Sketch A-A-12, dated May 27, 2005.
- 22) Plate 28, Basement Floor Plan Fire Protection: Add flow switches for each floor.
- 23) <u>Plate 33, Basement Floor Plan Plumbing</u>: Revise in accordance with the attached Sketch A-P-1, dated May 27, 2005.
- 24) <u>Plate 34, First Floor Plan Plumbing</u>: Revise in accordance with the attached Sketch A-P-2, dated May 27, 2005.
- 25) <u>Plate 36, Details Plumbing</u>: Revise details in accordance with the attached Sketches A-P-3 and A-P-4, dated May 27, 2005.
- 26) <u>Plate 37, Schedules Plumbing</u>: Revise in accordance with the attached Sketch A-P-5, dated May 27, 2005.

- 27) <u>Plate 41, Partial First Floor Plan, Office Area HVAC</u>: Change the following items:
  - a. Install fire dampers in the four (4) existing 40 x 16 supply air ducts where they penetrate the two hour fire rated wall between Storage Vault 110 and Work Area 112.
  - b. Tel-com Room 101 has been reduced in size. Contractor shall make the necessary adjustments in order to maintain the supply diffuser and the control panel for RTU-1 within that space.

#### **ATTACHMENTS**:

- 1) Sketches A-S-1, A-S-2, A-S-3, A-S-4, A-P-1, A-P-2, A-P-3, A-P-4, A-P-5, A-A-1, A-A-2, A-A-3, A-A-4, A-A-5, A-A-6, A-A-7, A-A-8, A-A-9, A-A-10, A-A-11 and A-A-12, dated May 27, 2005.
- 2) Revised Plate 24, dated May 27, 2005.

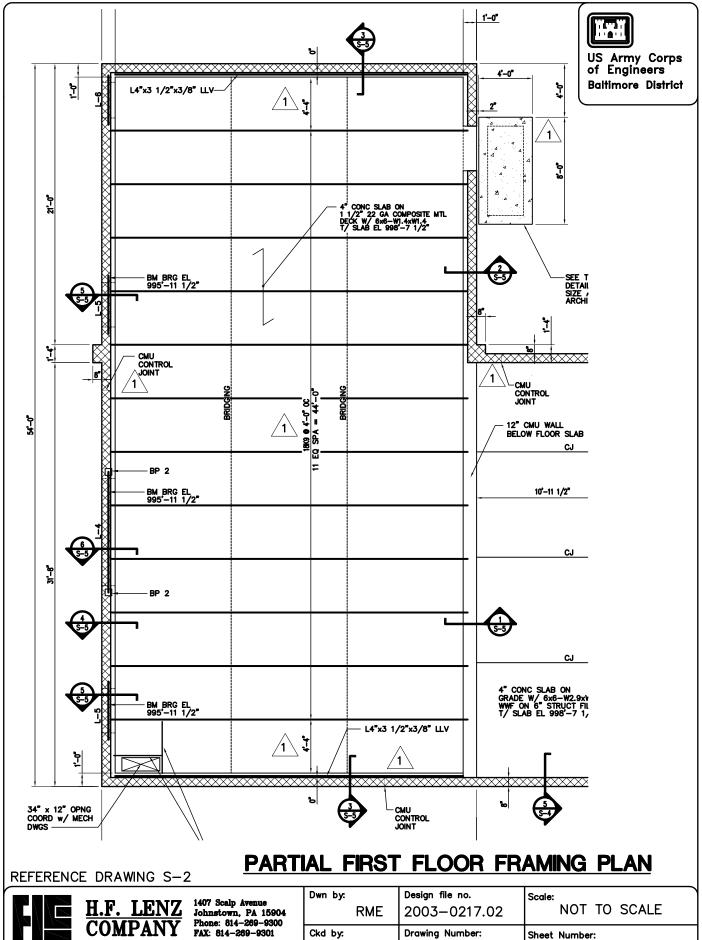


DEPARTMENT OF HOMELAND SECURITY ICE—NFU BALLISTIC TESTING RANGE ADAL ADDITION AND RENOVATIONS, ALTOONA, PA

A-S-1



3

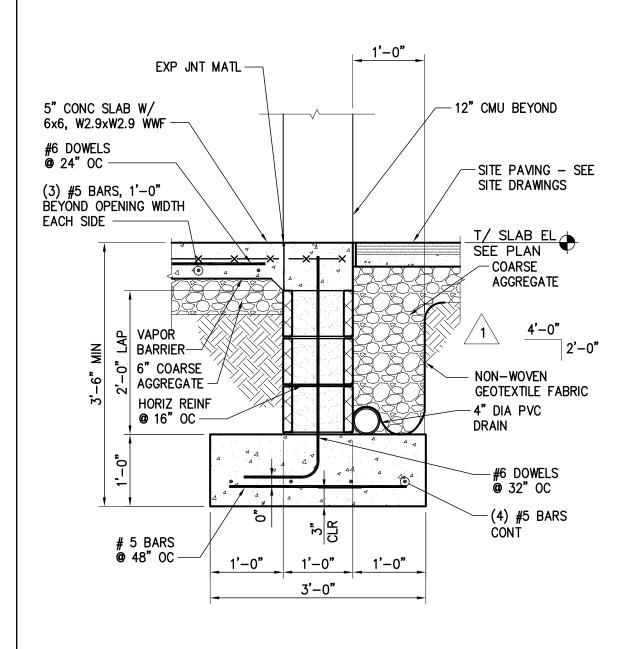



 $\frac{\text{H.F. LENZ}}{\text{COMPANY}}$ 


1407 Scalp Avenue Johnstown, PA 15904 Phone: 814-269-9300 FAX: 814-269-9301

DEPARTMENT OF HOMELAND SECURITY ICE—NFU BALLISTIC TESTING RANGE ADAL ADDITION AND RENOVATIONS, ALTOONA, PA


Dwn by: RME	Design file no. 2003-0217.02	Scale: AS NOTED
Ckd by: DM	Drawing Number: F—178—14—01	Sheet Number:
Submitted by: JCK	Date: 27 MAY 05	A-S-2


3/4" = 1'-0"




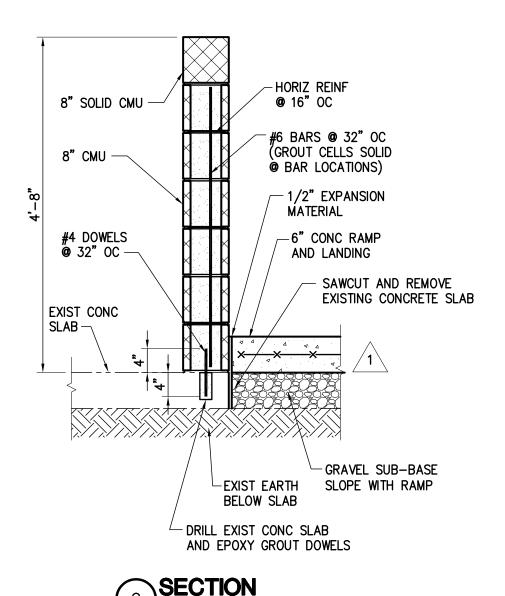

SCALE (A)

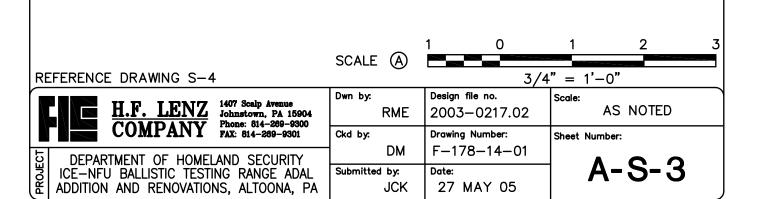

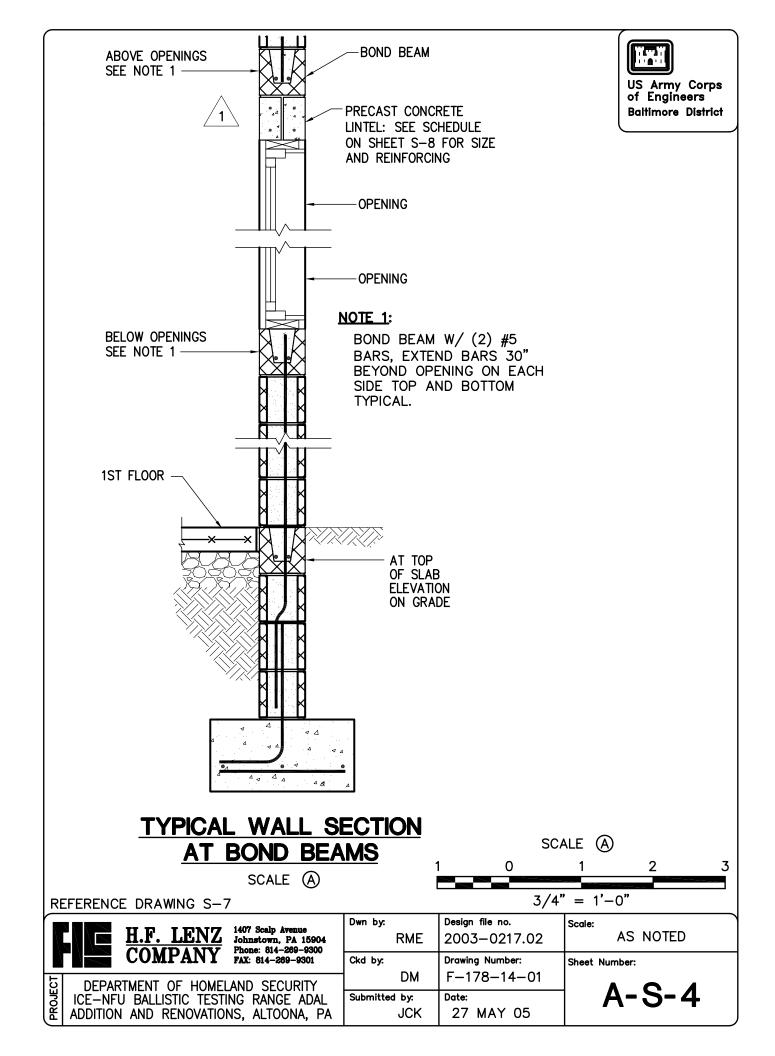

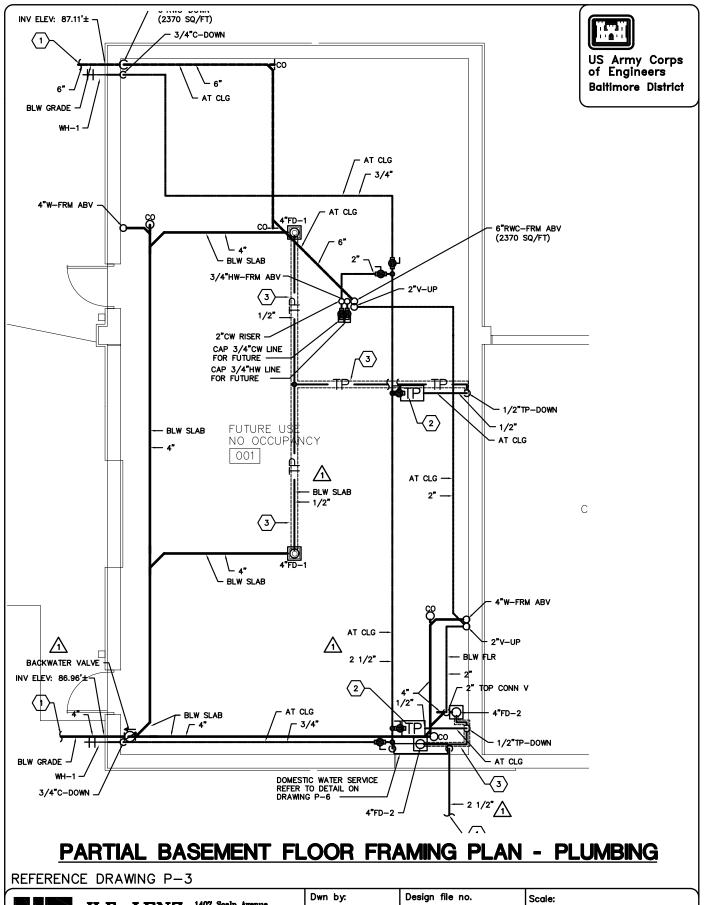



1407 Scalp Avenue Johnstown, PA 15904 Phone: 814-269-9300 FAX: 814-269-9301 Dwn by: Design file no. 2003-0217.02

Ckd by: Drawing Number: F-178-14-01


Submitted by: Date: 27 MAY 05

Sheet Number:


NOT TO SCALE

A-P-1

DEPARTMENT OF HOMELAND SECURITY ICE-NFU BALLISTIC TESTING RANGE ADAL ADDITION AND RENOVATIONS, ALTOONA, PA

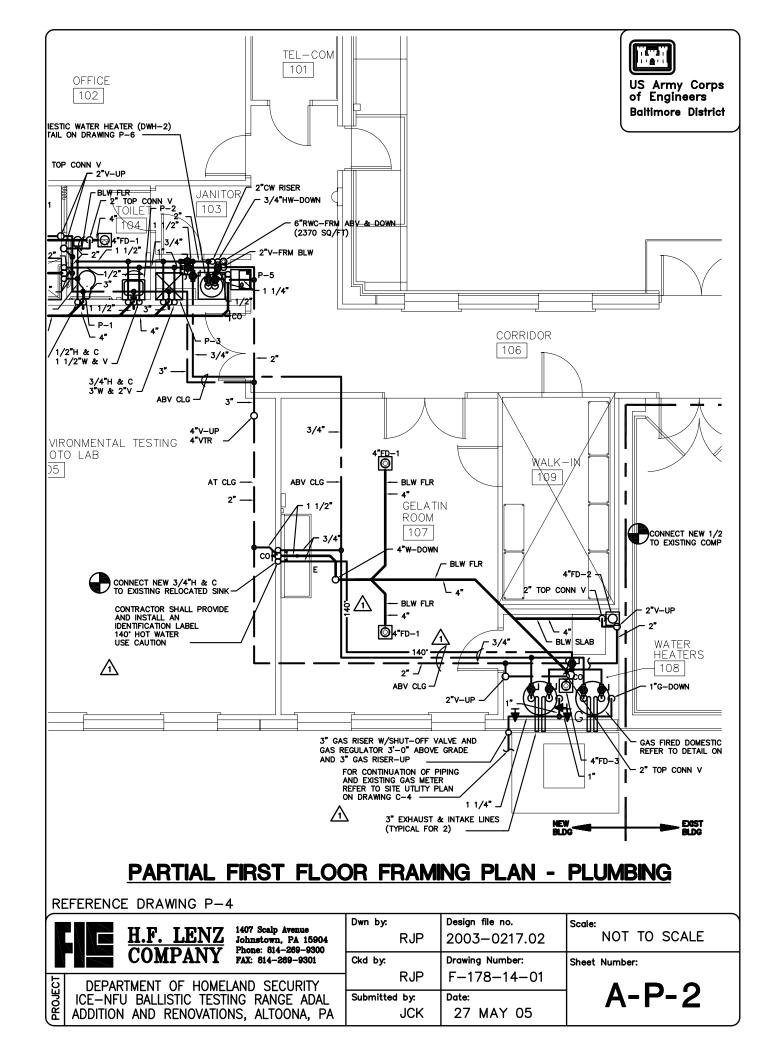



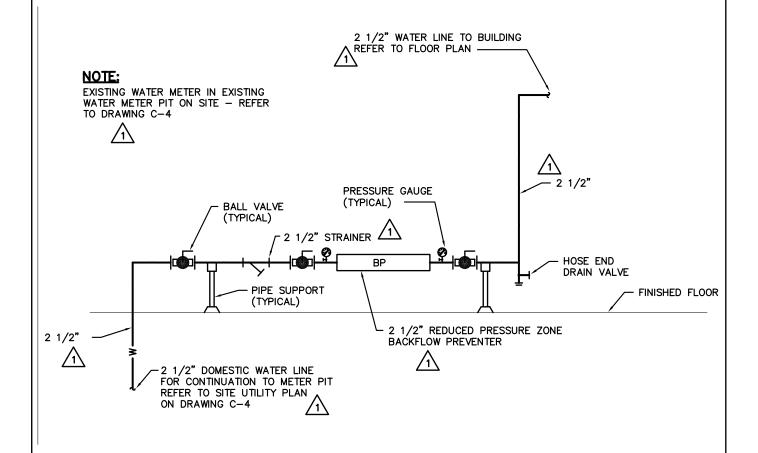

DOMESTIC WATER SERVICE SCHEMATIC

NO SCALE

Design file no.

REFERENCE DRAWING P-6



1407 Scalp Avenue Johnstown, PA 15904 Phone: 814-269-9300 FAX: 814-269-9301

 Ckd by:
 Drawing Number:

 RJP
 2003-0217.02

 Drawing Number:
 F-178-14-01

 Submitted by:
 Date:

 PA
 JCK
 27 MAY 05


Dwn by:

Scale:
AS NOTED

Sheet Number:
A-P-3

DEPARTMENT OF HOMELAND SECURITY ICE—NFU BALLISTIC TESTING RANGE ADAL ADDITION AND RENOVATIONS, ALTOONA, PA



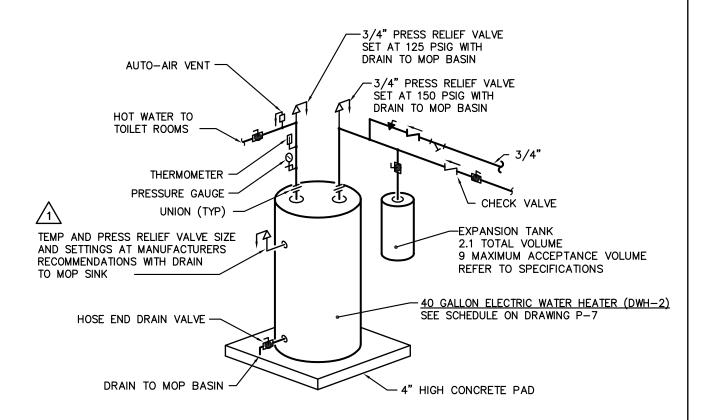

#### **ELECTRIC WATER STORAGE HEATER (DWH-2)** 6 NO SCALE

REFERENCE DRAWING P-6



1407 Scalp Avenue Johnstown, PA 15904 Phone: 814-269-9300 FAX: 814-269-9301

Dwn by:		Design file no.
RJ	Р	2003-0217.02
Ckd by:		Drawing Number:
RJ	Р	F-178-14-01
Submitted by:		Date:
JC	K	27 MAY 05

Scale: AS NOTED Sheet Number: A-P-4

LINONE	DEP.
3	ICE-N
	ADDITIO
-	1.00


'ARTMENT OF HOMELAND SECURITY
NFU BALLISTIC TESTING RANGE ADAL
ION AND RENOVATIONS, ALTOONA, PA





PLUMBING FIXTURE SCHEDULE						
NUMBER	TYPE OF FIXTURE	DRAII WP	NAGE VP	CW WA	TER HW	REMARKS * (SEE NOTE)
P-1	WATER CLOSET	4"	2"	1"		FLR MTD-FLUSH VALVE - HANDICAP
P-2	LAVATORY	1 1/2"	1 1/2"	1/2"	1/2"	WALL MTD-HANDICAP
P-3	SERVICE RECEPTOR	3"	2"	3/4"	3/4"	FLR MTD-STANDARD
P-4	SHOWER	3"	2"	1/2"	1/2"	FLR MTD-HANDICAP
P-5	ELECTRIC WATER COOLER	1 1/4"	1 1/4"	1/2"		WALL MTD-HANDICAP


\* NOTE: PLUMBING FIXTURE CONNECTIONS SHALL BE AS INDICATED UNLESS NOTED OTHERWISE ON DRAWING.

REFERENCE DRAWING P-7

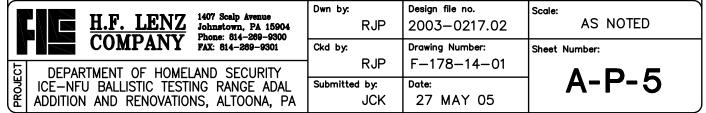

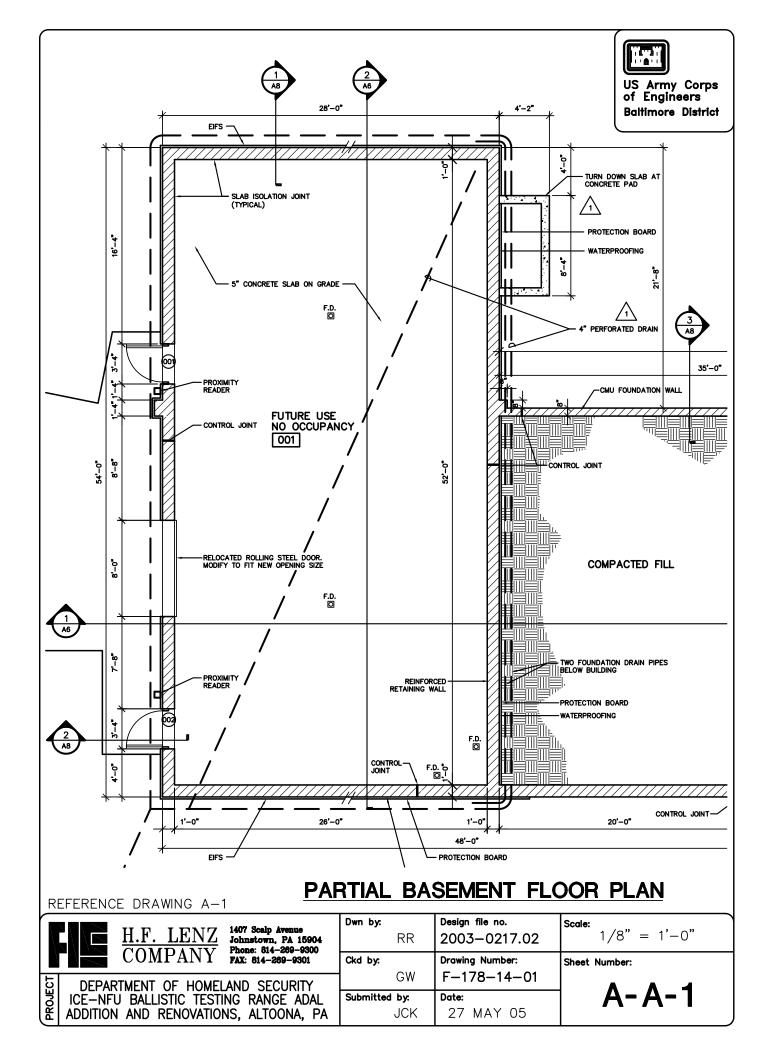


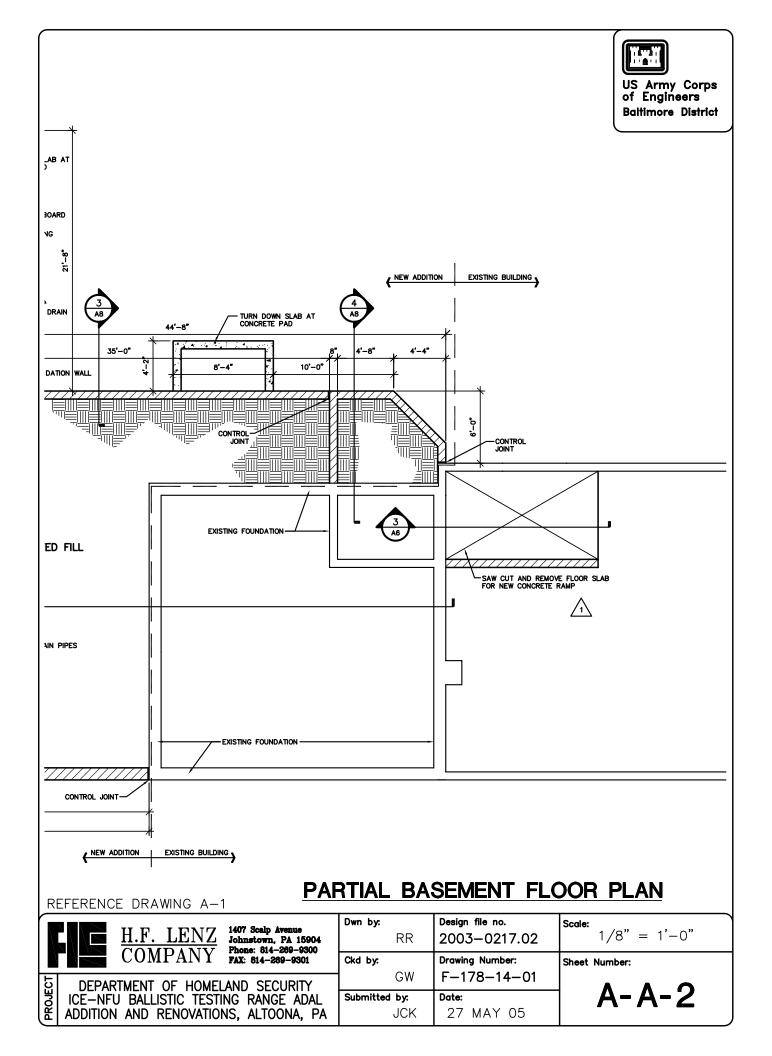

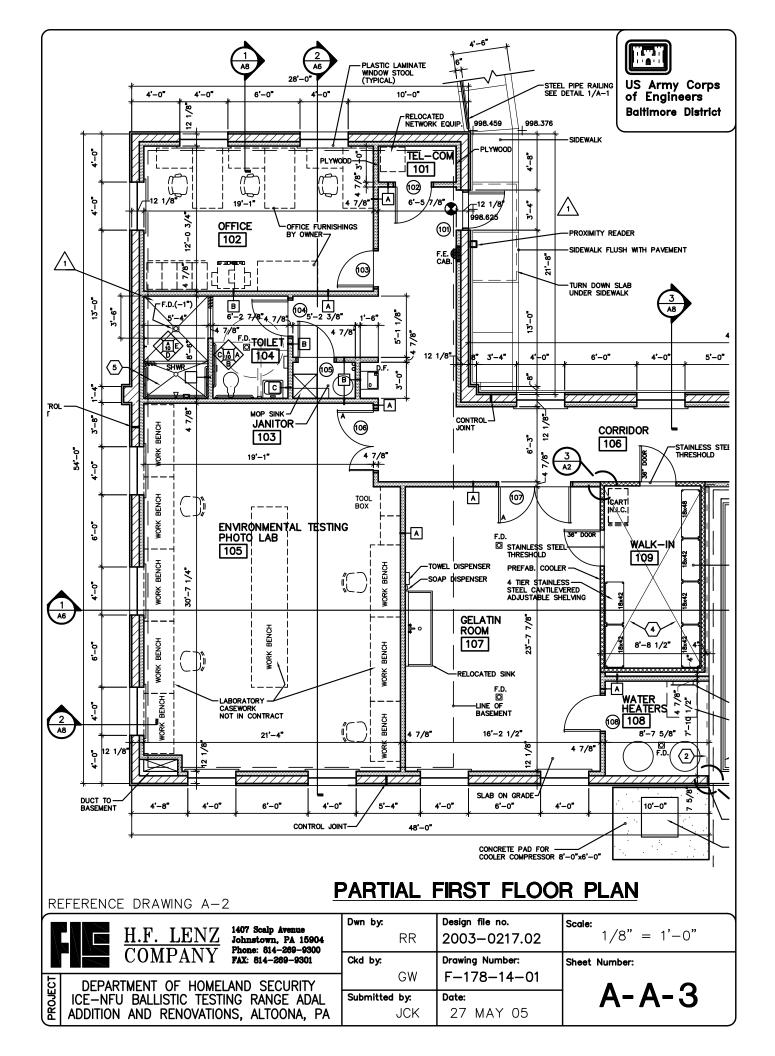





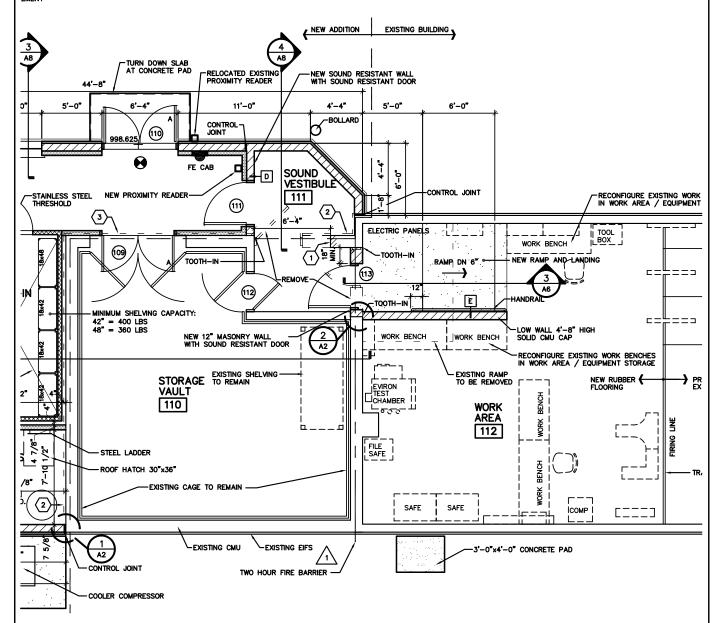

### PARTIAL FIRST FLOOR PLAN


			LEN IPAN	$\frac{L}{V}$ John	' Scalp Aven nstown, PA ne: 814-269- : 814-269-	15904 9300
ROJECT	DEPAR	J BALLI		STING	SECUF RANGE	

ADDITION AND RENOVATIONS, ALTOONA, PA

Dwn by: Design file no. RR 2003-0217.02 Drawing Number: Ckd by: F-178-14-01 GW Submitted by: Date: 27 MAY 05 JCK


Scale: 1/8" = 1'-0"Sheet Number: A-A-4



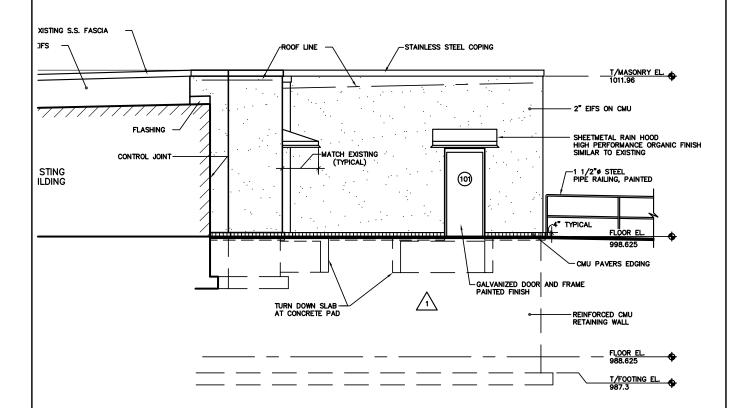


### EAST ELEVATION

REFERENCE DRAWING A-5

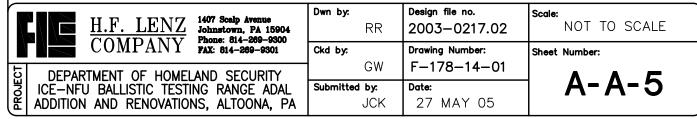



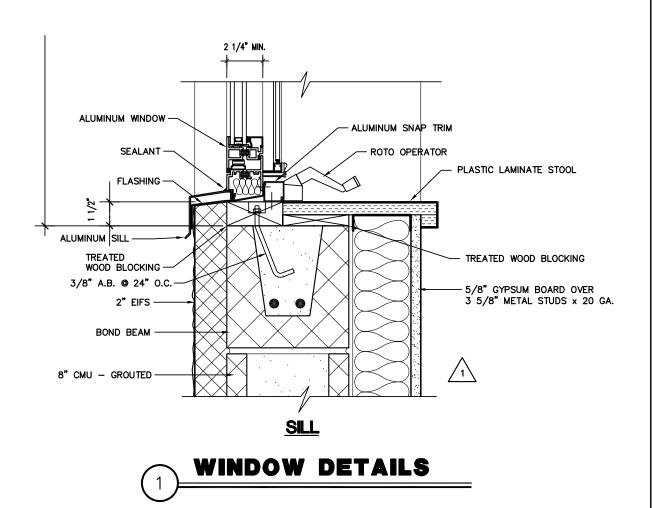




Dwn by:	Design file no.	
RR	2003-0217.02	
Ckd by:	Drawing Number:	
GW	F-178-14-01	
Submitted by:	Date:	
JCK	27 MAY 05	

NOT TO SCALE

Sheet Number:

A-A-6

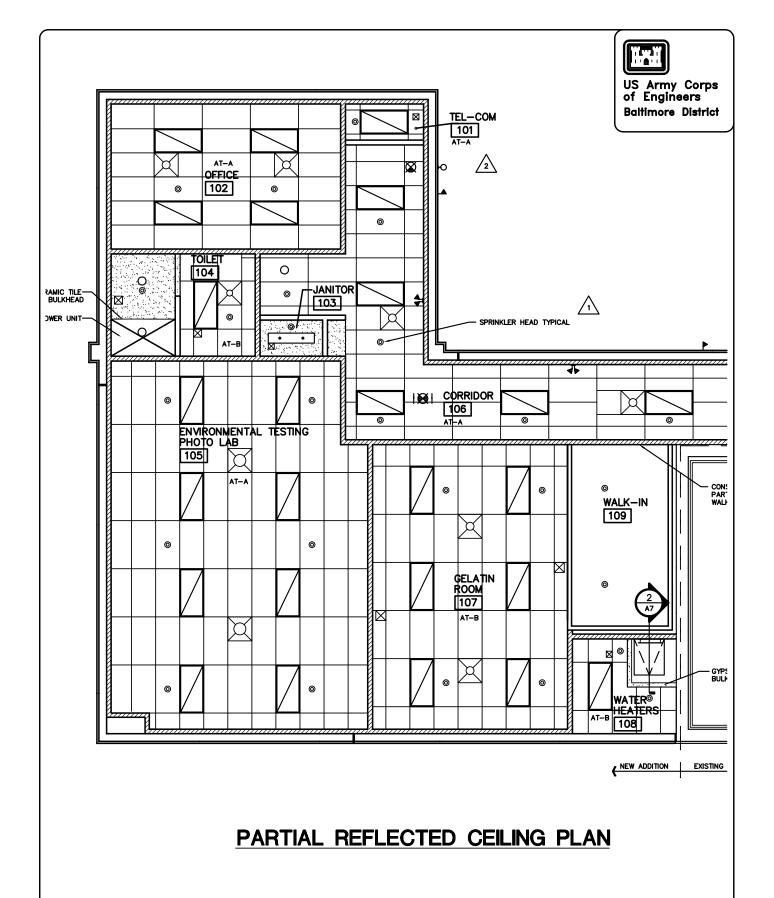




1407 Scalp Avenue Johnstown, PA 15904 Phone: 814-269-9300 FAX: 814-269-9301

Dwn by: Design file no. 2003-0217.02 RR Ckd by: Drawing Number: F-178-14-01 GW Submitted by: Date: 27 MAY 05 **JCK** 

Scale: 1/8" = 1'-0"Sheet Number: A-A-7



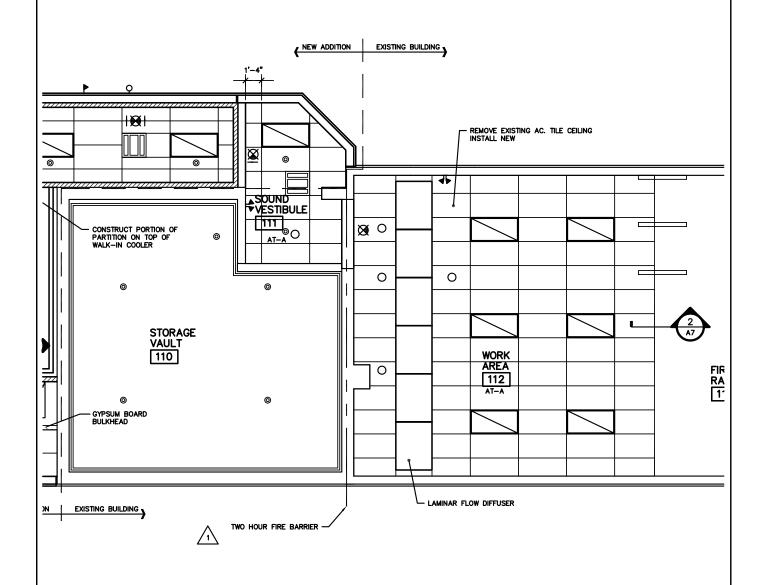

### PARTIAL REFLECTED CEILING PLAN

REFERENCE DRAWING A-7

 $\frac{\text{H.F. LENZ}}{\text{COMPANY}}$ 

1407 Scalp Avenue Johnstown, PA 15904 Phone: 814-269-9300 FAX: 814-269-9301

DEPARTMENT OF HOMELAND SECURITY
ICE—NFU BALLISTIC TESTING RANGE ADAL
ADDITION AND RENOVATIONS, ALTOONA, PA

 Dwn by:
 Design file no.

 RR
 2003-0217.02

 Ckd by:
 Drawing Number:

 F-178-14-01


 Submitted by:
 Date:


 JCK
 27 MAY 05


Sheet Number:
A-A-8

1/8" = 1'-0"


Scale:

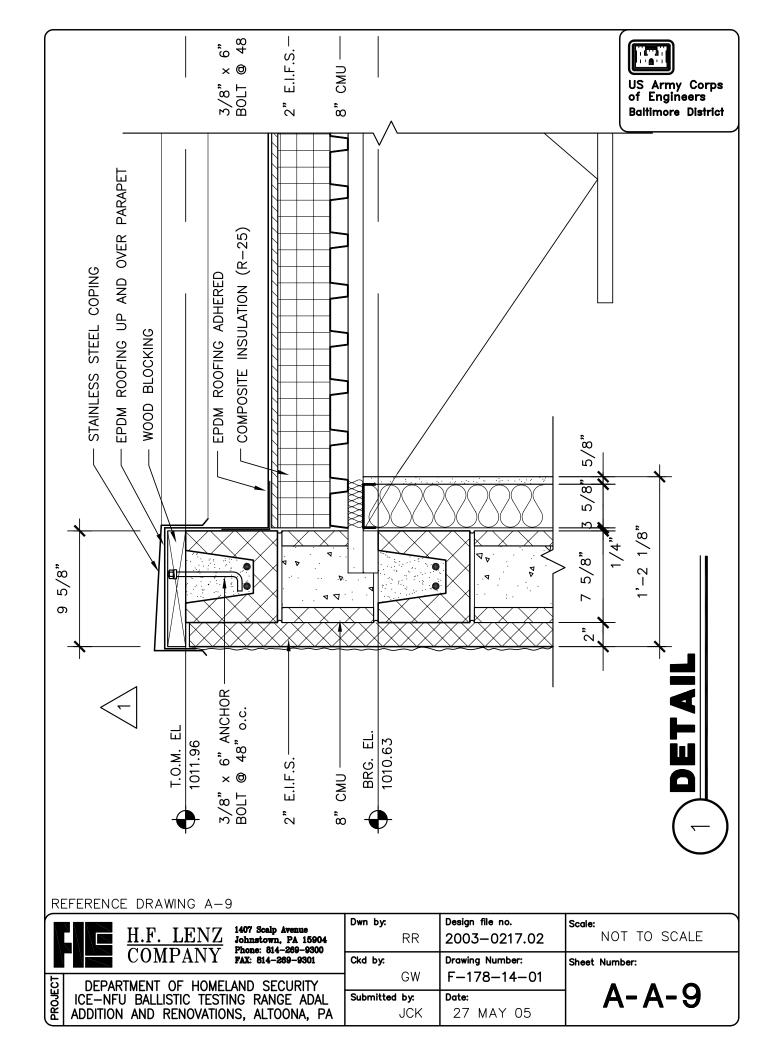

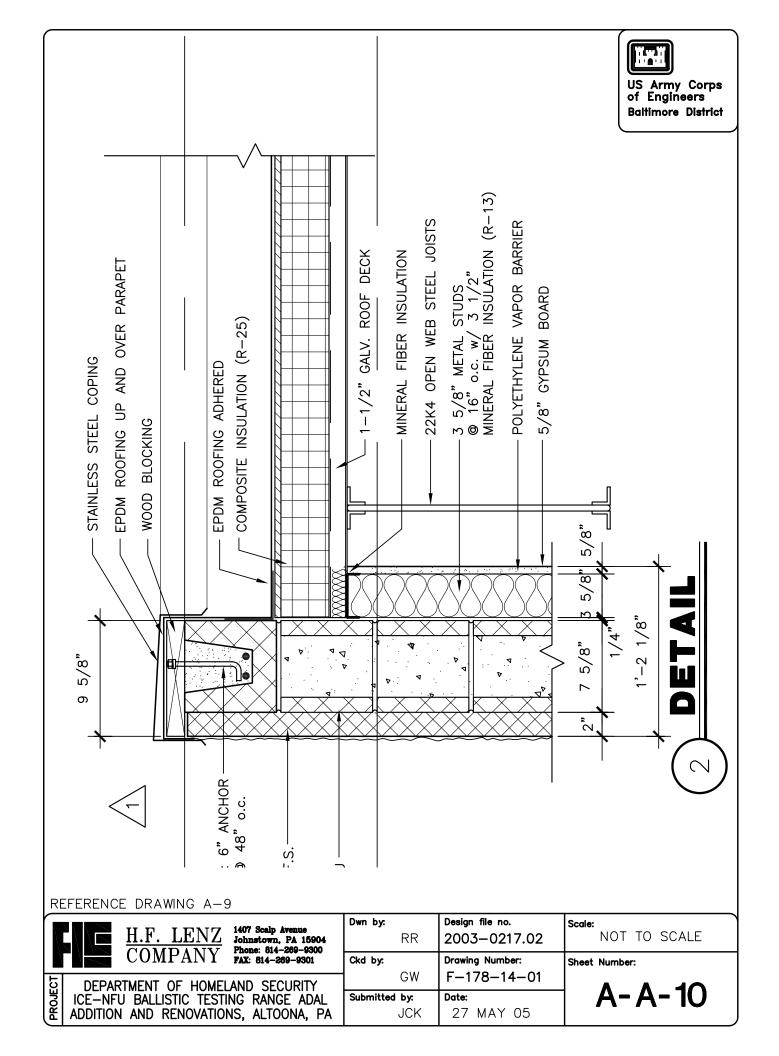

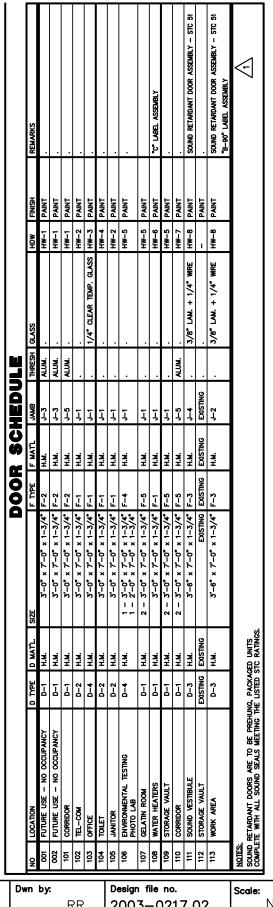



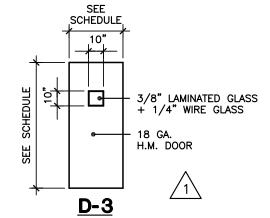

H.F. LENZ COMPANY

1407 Scalp Avenue Johnstown, PA 15904 Phone: 814-289-9300 FAX: 814-269-9301

DEPARTMENT OF HOMELAND SECURITY ICE—NFU BALLISTIC TESTING RANGE ADAL ADDITION AND RENOVATIONS, ALTOONA, PA


Dwn by: RR	Design file no. 2003-0217.02
Ckd by: GW	Drawing Number: F—178—14—01
Submitted by: JCK	<b>Date:</b> 27 MAY 05

rale: NOT TO SCALE

Sheet Number:

A-A-11



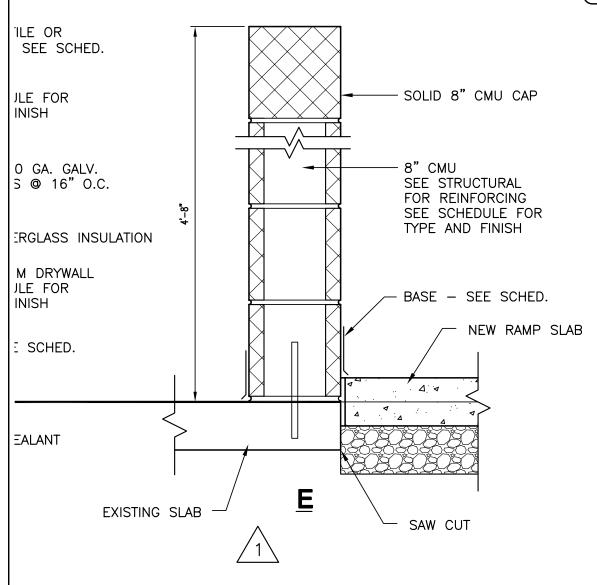

## PARTITION TYPES

REFERENCE DRAWING A-10



1407 Scalp Avenue Johnstown, PA 15904 Phone: 814-269-9300 FAX: 814-269-9301

DEPARTMENT OF HOMELAND SECURITY
ICE—NFU BALLISTIC TESTING RANGE ADAL
ADDITION AND RENOVATIONS, ALTOONA, PA

Dwn by:	Design file no.
RR	2003-0217.02
Ckd by:	Drawing Number:
GW	F-178-14-01
Submitted by:	Date:
JCK	27 MAY 05

Scale: NOT TO SCALE

Sheet Number:

A-A-12